


GENERAL NOTES


- A. THESE DRAWINGS ARE SUPPLEMENTED BY THE DESIGN NARRATIVE PROVIDED DURING THE SITE SELECTION PROCESS. REFERENCE THE WRITTEN NARRATIVE FOR ADDITIONAL INFORMATION, ACCEPTABLE MANUFACTURERS, & OTHER QUALITY INFORMATION.
- B. ALL DIMENSIONS ARE FROM FACE OF STUD, OR FACE OF GRT, OR FACE OF C.M.U. ANY DIMENSIONS NOT SHOWN OR DEEMED QUESTIONABLE ARE TO BE VERIFIED BY ARCHITECT. DO NOT SCALE DRAWINGS.
- C. PROVIDE WOOD BLOCKING SUPPORTS AS REQUIRED FOR ALL SURFACE MOUNTED ITEMS.
- D. COORDINATE WORK OF THIS TRADE WITH OTHER TRADES.
- E. DOOR AND FRAME NUMBERS CORRESPOND TO ROOM NUMBERS. WHERE MORE THAN ONE DOOR OCCURS IN A ROOM, A SUFFIX HAS BEEN ADDED (I.E. 100A). SEE DIVISION 500 DRAWINGS FOR DOOR SCHEDULE.
- F. APPLY SEALANT AT ALL JUNCTURES BETWEEN DIFFERENT MATERIALS (I.E. STOREFRONT AND CONCRETE).
- G. ALL STEEL STUDS ARE TO BE BRACED ACCORDING TO MANUFACTURER'S LIMITING HEIGHT L/240.

PLAN NOTES:

1. PRE-MANUFACTURED PRE-FINISHED METAL CANOPY STRUCTURE.
2. HIGH VOLUME LOW SPEED FAN PREFERRED LOCATION. COORDINATE EXACT LOCATION AROUND LIGHTS, SPRINKLERS AND STRUCTURAL LIMITATIONS.
3. PROVIDE LEVELER PIT, DOCK LEVELER, DOCK SEAL, BUMPER, DOCK LIGHTS, DOCK FAN & DOCK EQUIPMENT CONTROLLER & TRACK PROTECTION. SEE DETAIL 3/A101.
4. SATELLITE DISH MAST ABOVE. SEE DETAIL 2/A101.
5. REMOVE EXISTING DOOR & INFILL W/ STOREFRONT.
6. REMOVE EXISTING DOCK DOOR FOR REUSE ELSEWHERE.
7. PROVIDE NEW STOREFRONT OPENING IN EXISTING CONCRETE WALL. COORDINATE EXACT SIZES WITH EXISTING PLANNED K.O. PANELS, EXISTING OPENINGS, OR LIMITATIONS OF CONCRETE PANELS.
8. REPLACE VISION GLASS BELOW 10'-0" A.F.F. WITH SPANDREL GLASS. (ALTERNATE: ADD BLACK-OUT FILM ON INTERIOR SIDE OF GLAZING. PROVIDE FIELD MOCK-UP FOR APPROVAL.)
9. EXISTING DOOR TO REMAIN. PROVIDE SLIDE LOCKS ON BOTH SIDES OF EXISTING DOOR.
10. REPLACE EXISTING DOOR HARDWARE WITH RIM PANIC DEVICE & NO ENTRANCE HARDWARE.
11. REPLACE EXISTING H.M. DOOR & FRAME WITH WIDE STYLE STOREFRONT DOOR.
12. JIB CRANE OUTRIGGER LOCATION ABOVE. SEE DETAIL 1/M451.
13. (ALTERNATE) INTERIOR ROOF STAIR AND EQUIPMENT PLATFORM LOCATION. SEE DETAIL 2/M451.
14. PROVIDE (4) 4" CONDUITS FOR TENANT USE FROM DEMARK LOCATION IN PUMP ROOM TO DEMARK PANEL IN SERVER ROOM.
15. PROVIDE NEW STOREFRONT OPENING IN EXISTING DOCK DOOR LOCATION.
16. 7'-0" HIGH CHAIN LINK FENCE W/ 6'-0" SLIDING GATE.
17. 7'-0" HIGH CHAIN LINK FENCE W/ 3'-0" GATE DOOR.
18. 12" WIDE AUTOMATIC SLIDING DOOR. STANLEY DURAGLIDE 3000. CONTACT NATIONAL ACCOUNT FOR ORDERING INFORMATION.
19. ROUTE (2) 4" CONDUITS FROM EXISTING DEMARK OVERHEAD IN STRUCTURE & TERMINATE IN SERVER ROOM ABOVE PHONE BOARD.
20. REMOVE EXISTING STAIR & REPLACE W/ ROTATED CAST-IN-PLACE CONCRETE STAIR. REFERENCE XXXX FOR ADDITIONAL INFORMATION.

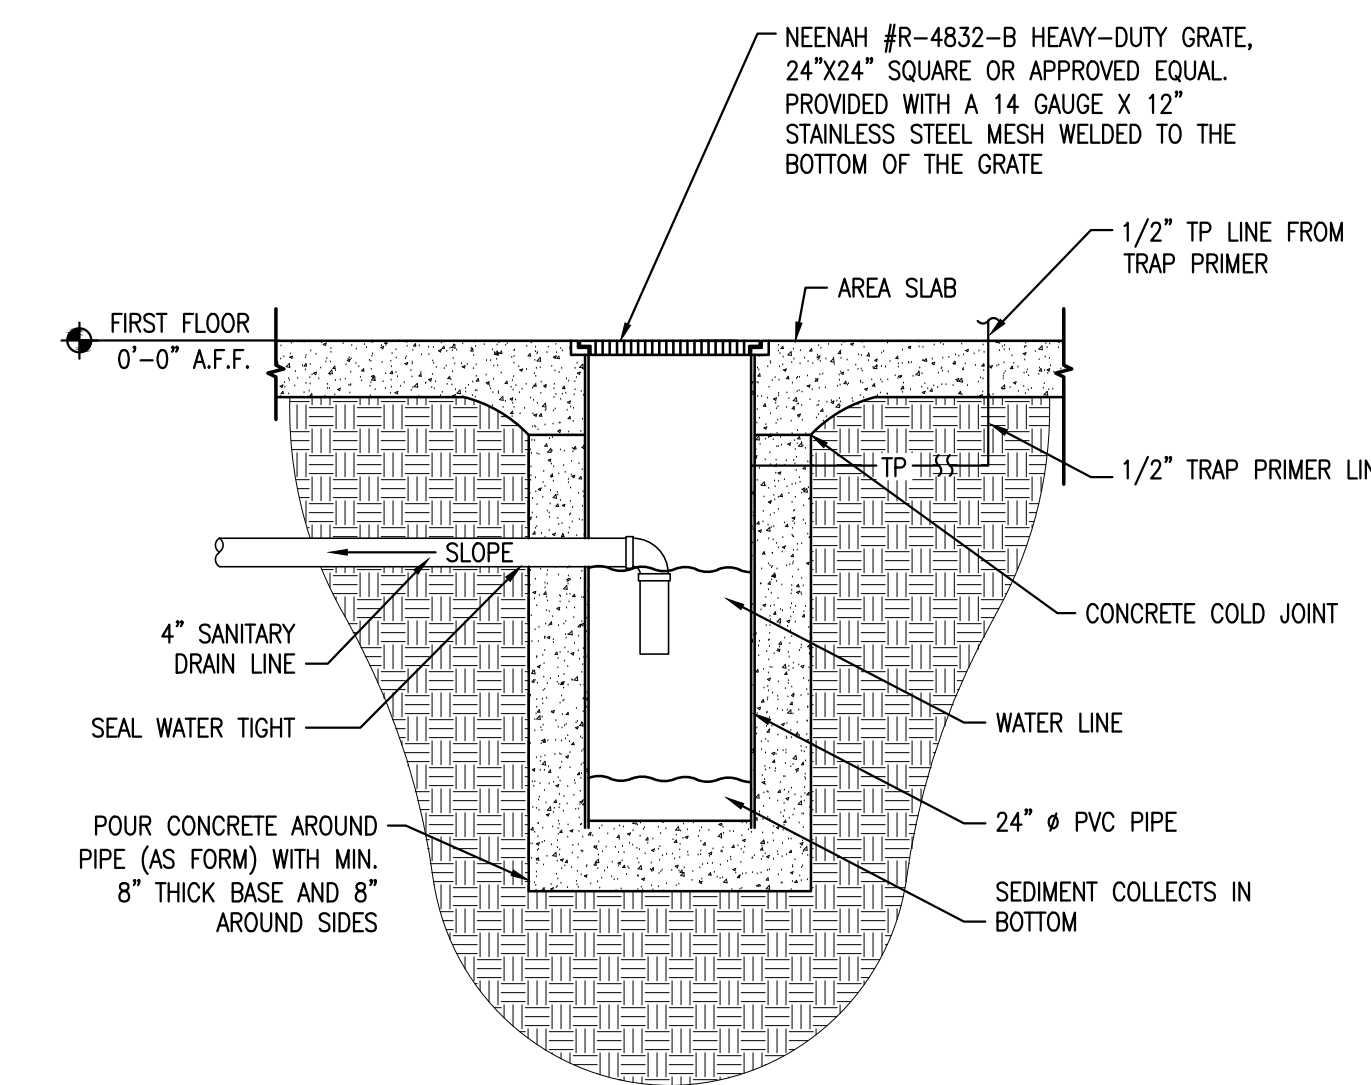


5 SEDIMENT BASIN DRAIN DETAIL
SCALE: 1/2" = 1'-0"

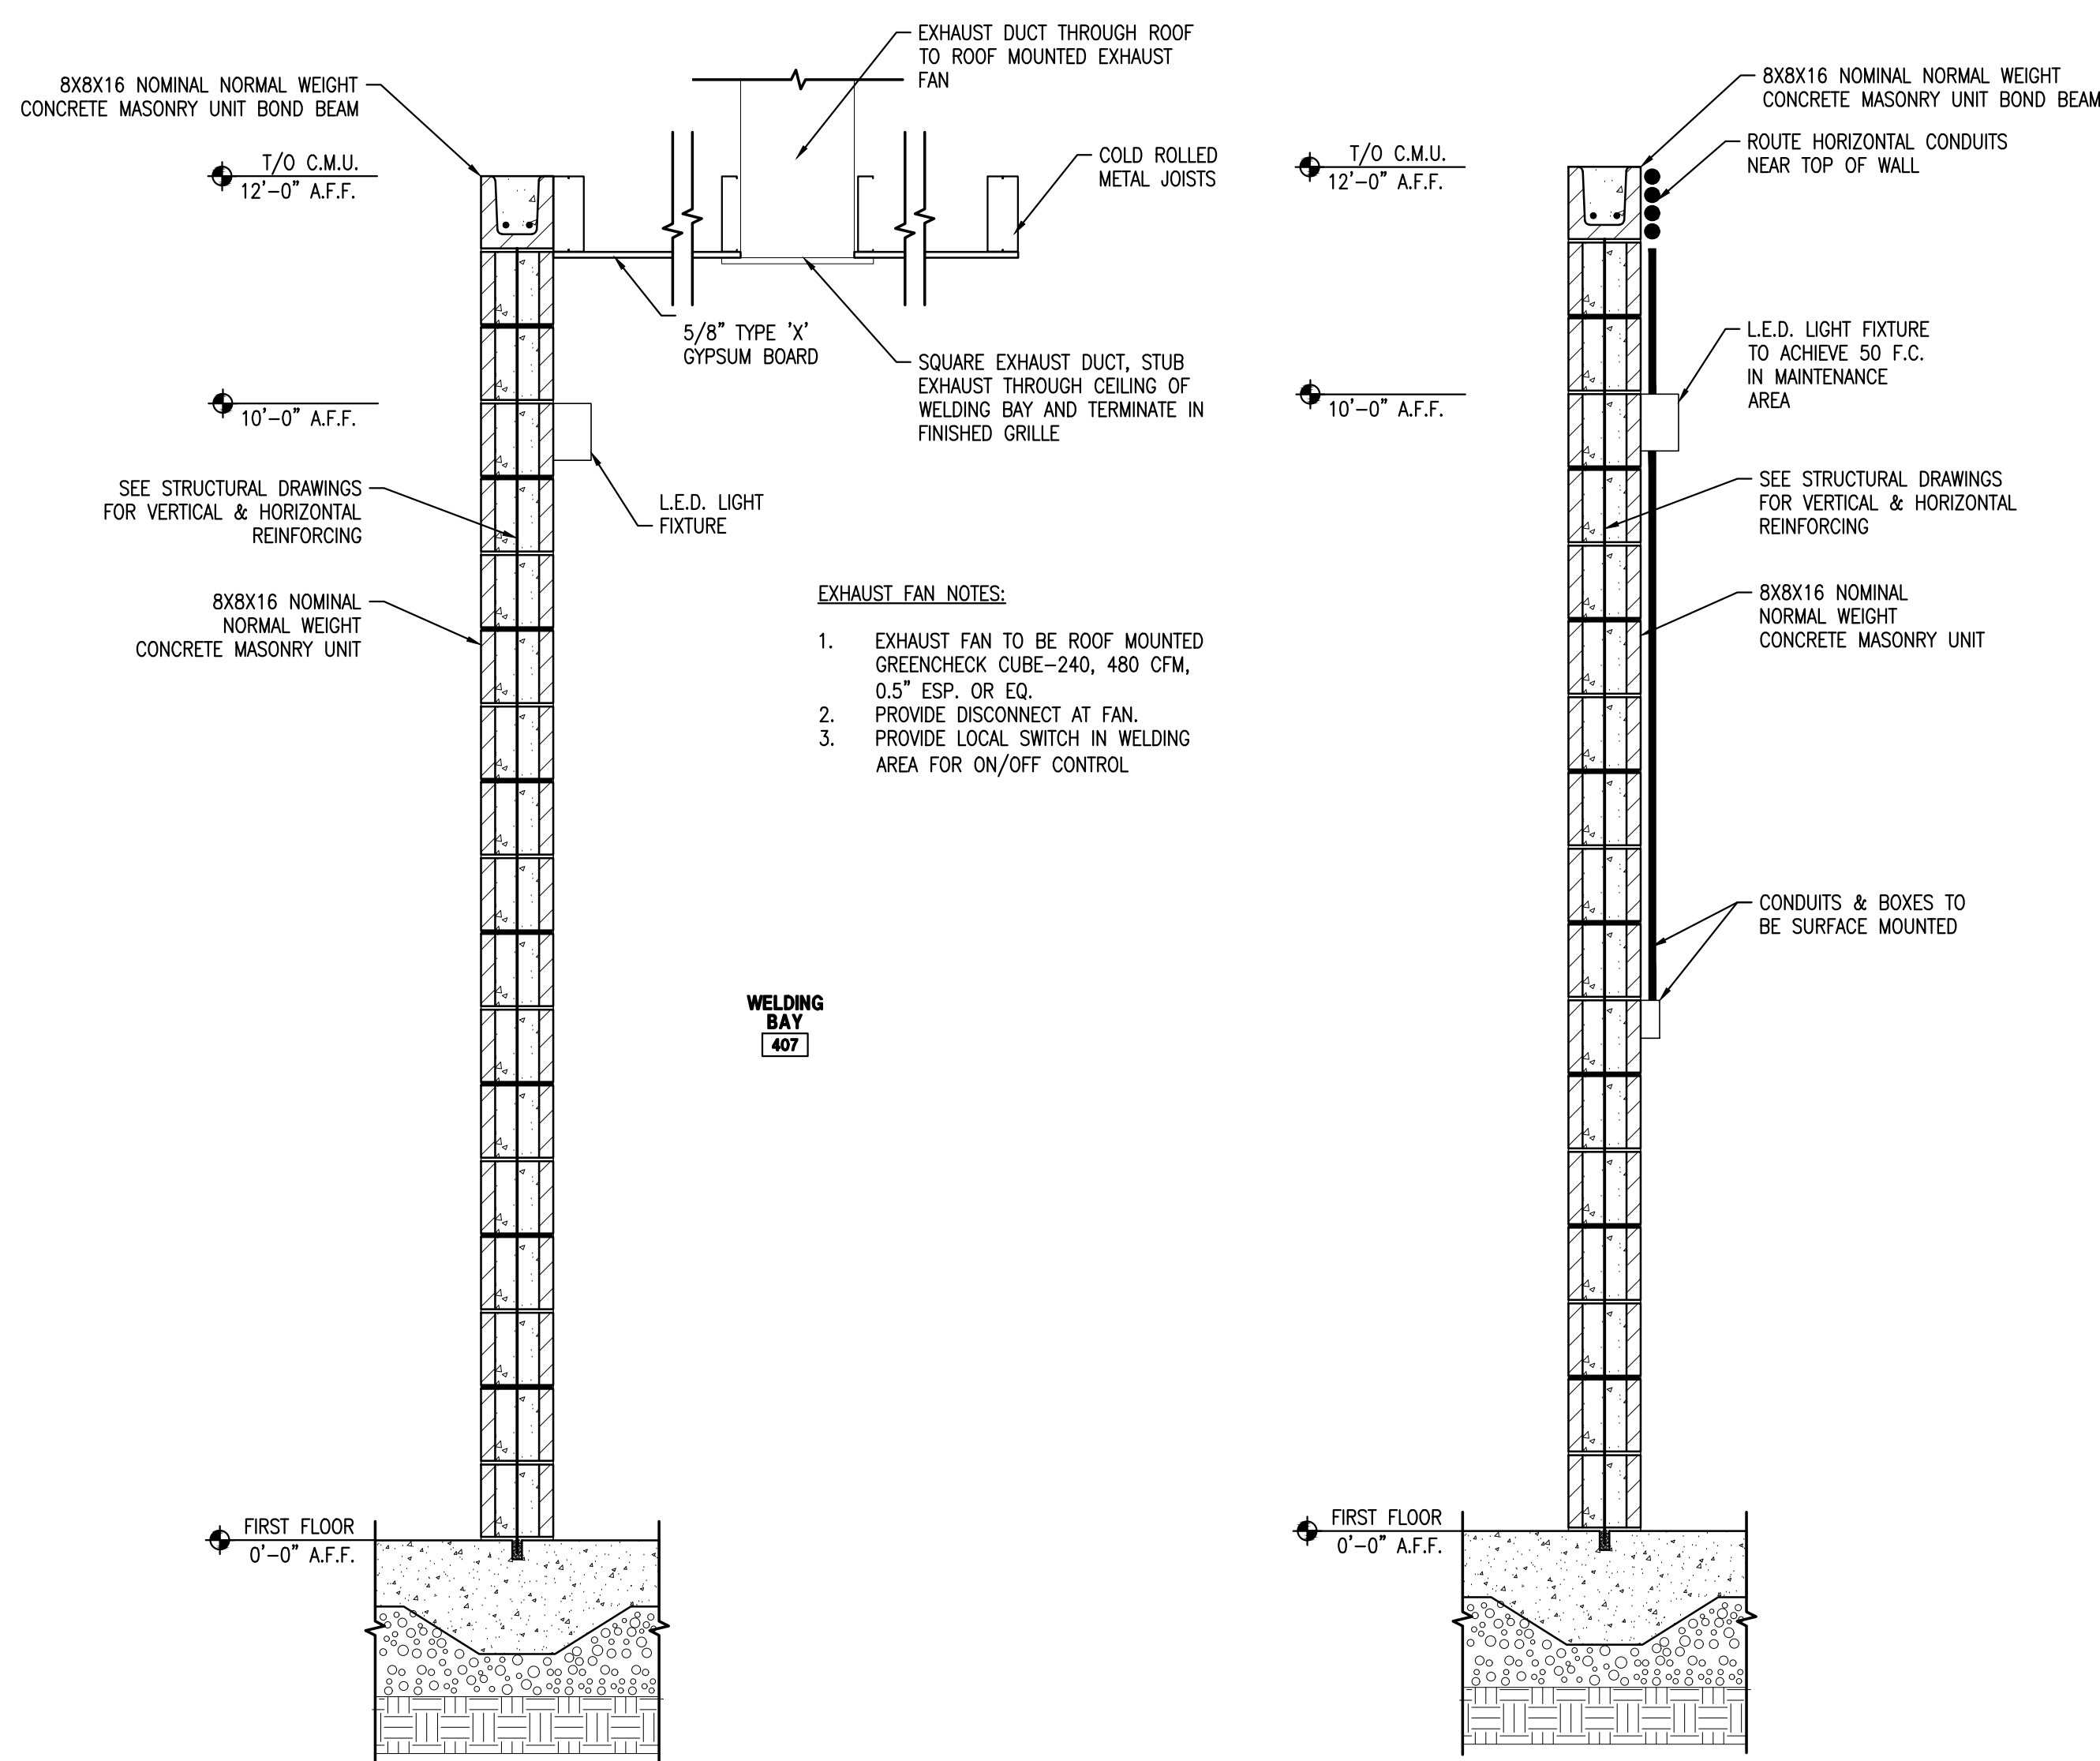


4 WALL SECTION
SCALE: 3/4" = 1'-0"

3 WALL SECTION
SCALE: 3/4" = 1'-0"

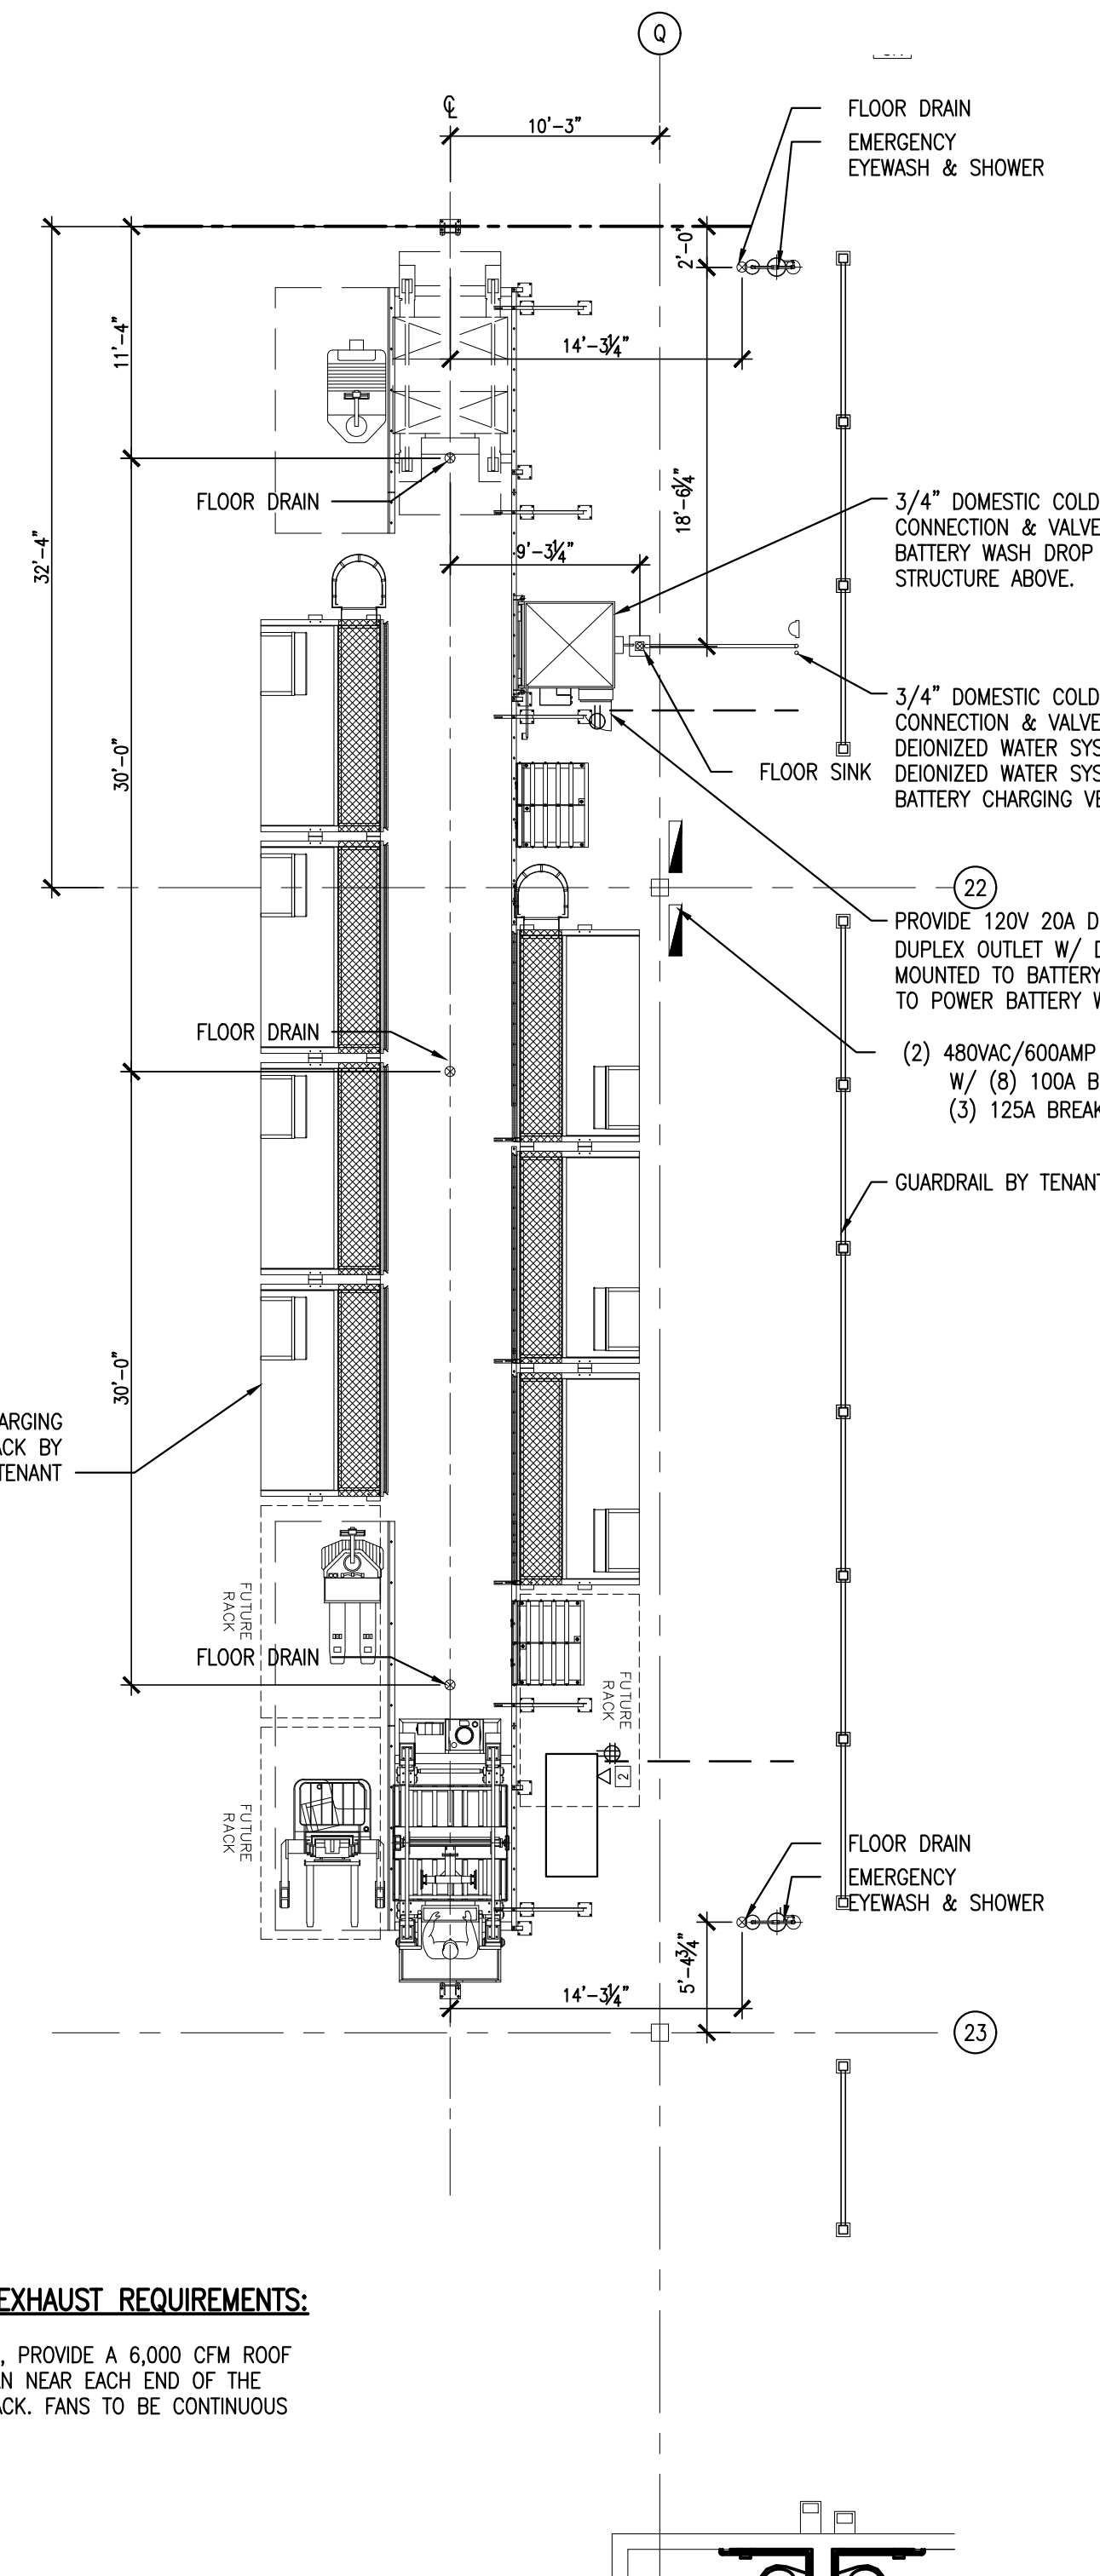

2 ENLARGED BATTERY CHARGING FLOOR PLAN
SCALE: 1/8" = 1'-0"

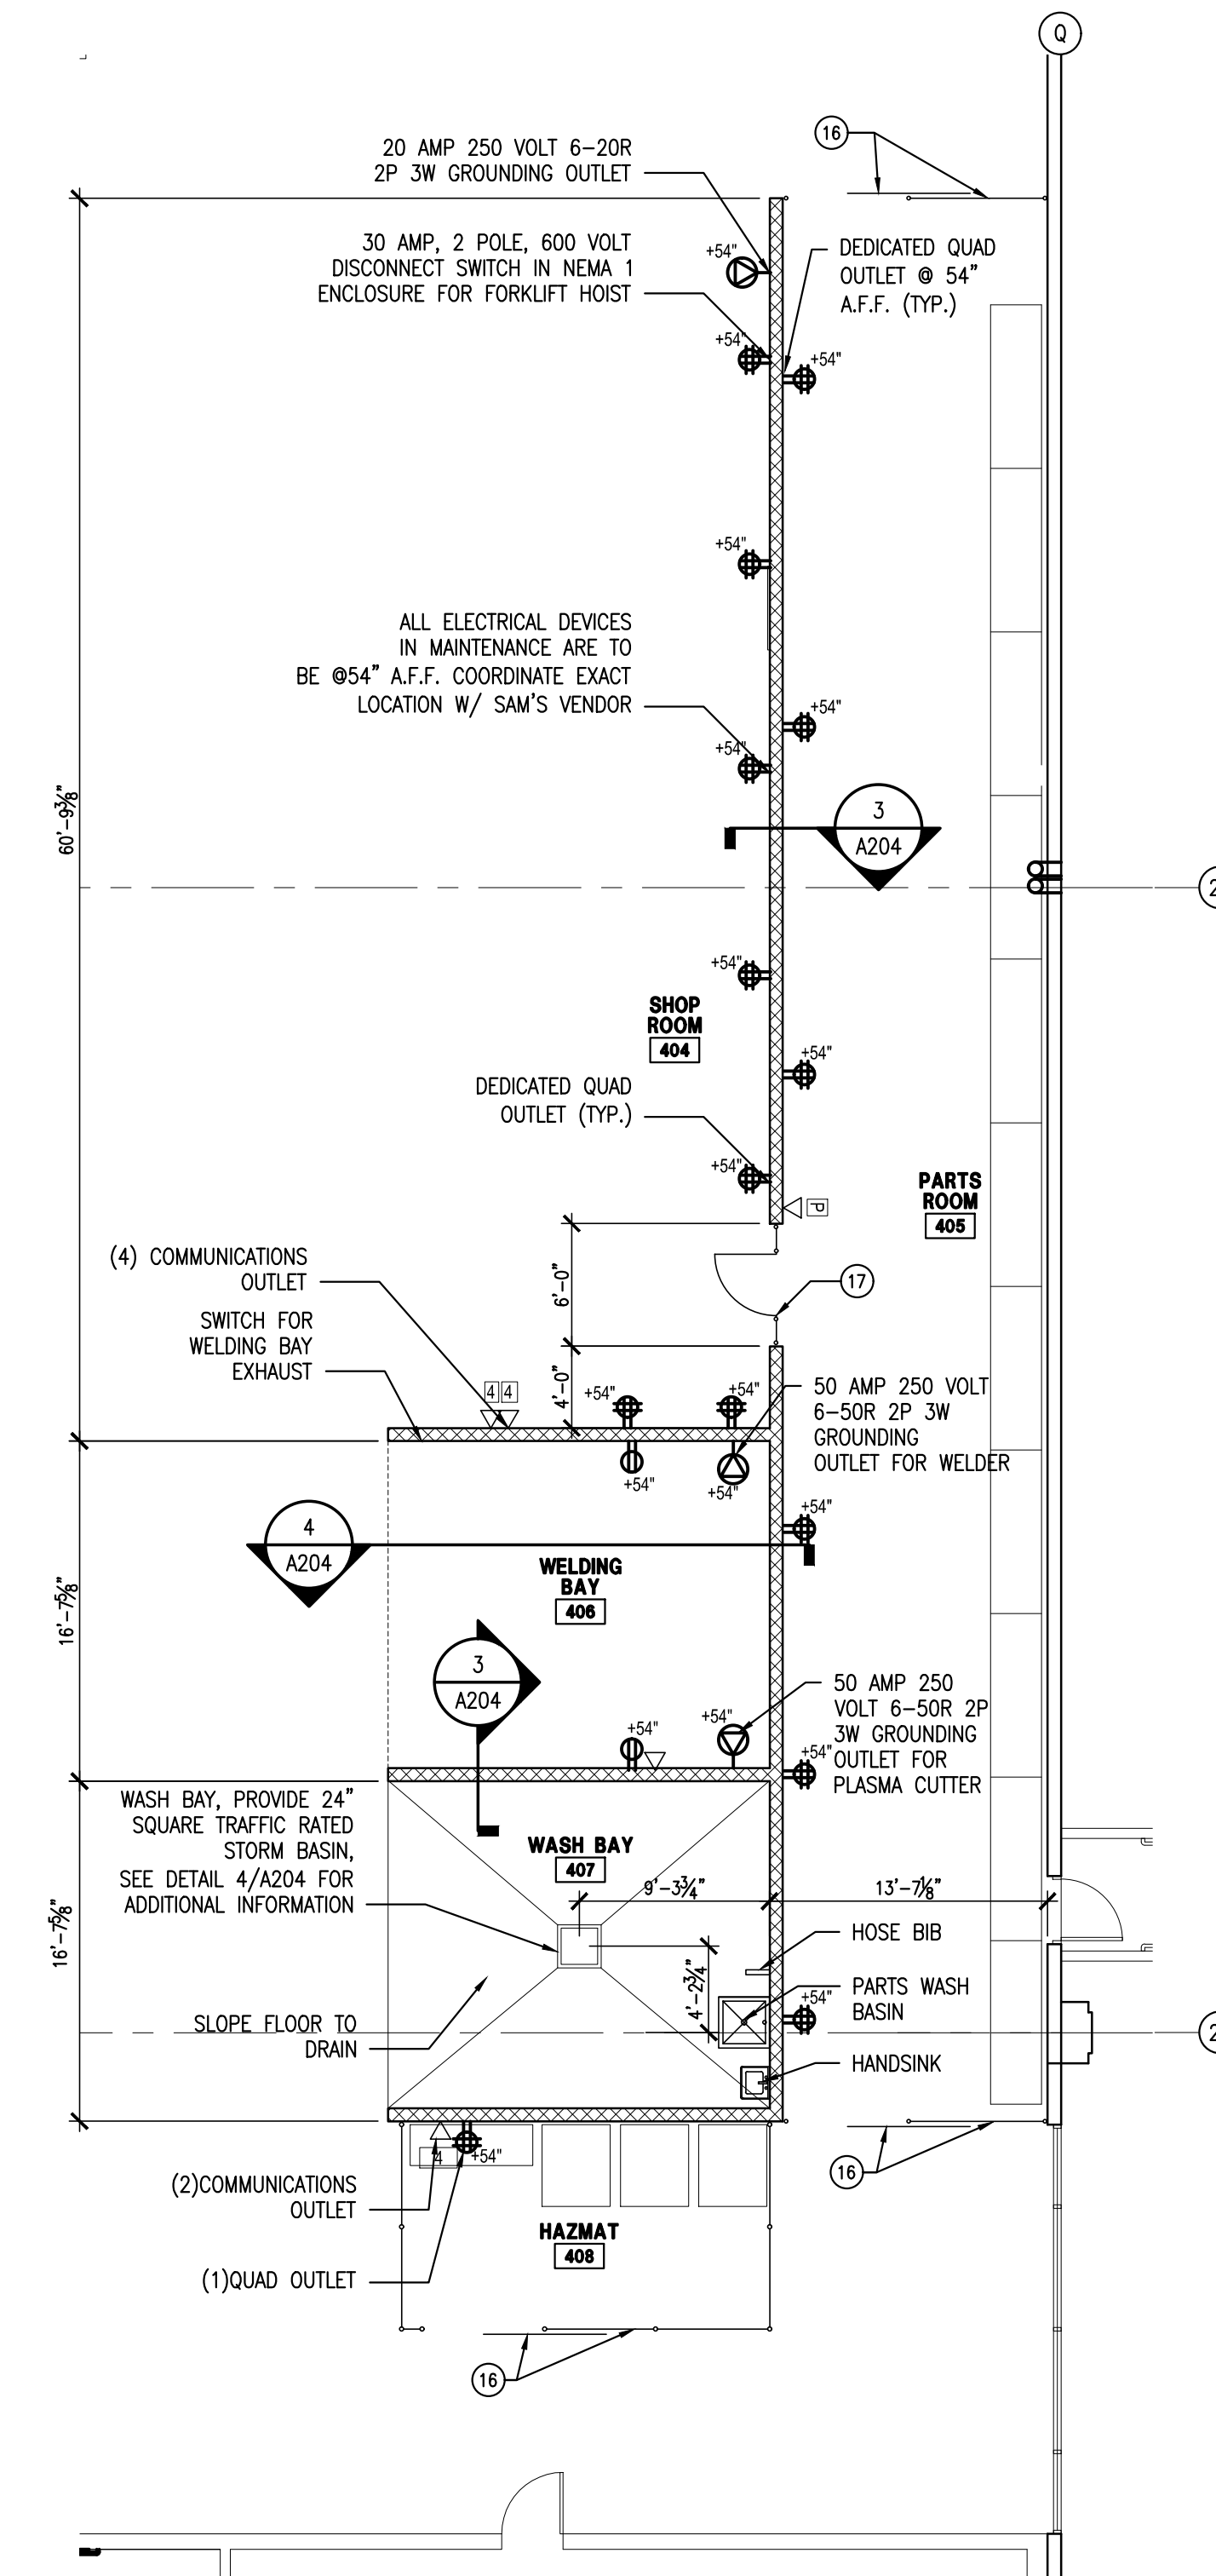

1 ENLARGED AREA 400 MAINTENANCE FLOOR PLAN
SCALE: 1/8" = 1'-0"

BATTERY CHARGING EXHAUST REQUIREMENTS:

- IN AMBIENT BUILDINGS, PROVIDE A 6,000 CFM ROOF MOUNTED EXHAUST FAN NEAR EACH END OF THE BATTERY CHARGING RACK. FANS TO BE CONTINUOUS OPERATION.

SCOPE DRAWINGS:
These drawings indicate the general scope of the project in terms of mechanical scope, contact the designer for all structural, mechanical and electrical systems.
The drawings do not necessarily indicate the quantity of work required for full performance and completion of the requirements of the Contract.

REVISIONS:

ISSUE DATE	DRAWN BY	CHECKED BY
01/17/20	---	---

DRAWING TITLE:
ENLARGED AREA 400 MAINTENANCE & BATTERY CHG. PLAN

CERTIFIED BY:
PRELIMINARY FOR REVIEW/ NOT FOR CONSTRUCTION

DRAWING NUMBER:
A204

PROJECT NUMBER:
19126

PROJECT:
SAM'S CLUB FC
22722 HARLEY KNOX BLVD.
RIVERSIDE, CA